CHAPTER 20.

6. TO THE BEST OF OUR KNOWLEDGE, THE PRODUCT SHOWN HEREIN IS CERTIFIED & QUALITY ASSURED BY A FLORIDA STATE APPROVED CERTIFICATION/QA ENTITY & SHALL BE LABELED IN ACCORDANCE WITH THE FBC AND THE FLORIDA DEPARTMENT OF BUSINESS & PROFESSIONAL REGULATION SPECIFICATIONS. PRODUCT ASSEMBLY IS NOT PART OF THIS DRAWING AND SHALL BE IN ACCORDANCE WITH THE MANUFACTURER'S QUALITY ASSURANCE SPECIFICATIONS & TESTING REPORTS. 1. ALL FASTENERS SHALL BE IN ACCORDANCE WITH THESE DRAWINGS. SPECIFIED ANCHOR EMBED TO BASE MATERIAL SHALL BE BEYOND WALL FINISH OR STUCCO.

2. OPENINGS, BUCKING & BUCKING FASTENERS MUST BE PROPERLY DESIGNED & INSTALLED TO TRANSFER WIND LOADS TO THE STRUCTURE.

3. THESE NON-IMPACT RATED PRODUCT INSTALLATIONS ARE IN ACCORDANCE WITH AND MEET THE REQUIREMENTS OF THE FLORIDA BUILDING CODE (FBC).

4. ALL ANCHORS SECURING PRODUCT FRAMES TO PRESSURE TREATED BUCKS OR WOOD FRAMING SHALL BE CAPABLE OF RESISTING CORROSION CAUSED BY THE PRESSURE TREATING CHEMICALS IN THE WOOD.

5. MATERIALS, INCLUDING BUT NOT LIMITED TO STEEL SCREWS, THAT COME INTO CONTACT WITH OTHER DISSIMILAR MATERIALS SHALL MEET THE REQUIREMENTS OF FLORIDA BUILDING CODE

HEAD & SHALL NOT ACT AS A SUBSTITUTE FOR THE FRAME

FOR MAX. FRAME WIDTH, SEE "ALLOWABLE

DE

SIGN

PRESSURE" TABLE ON THIS SHEET

10" MAX. O.C.

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FIN IS OPTIONAL AT ANCHORING OF NAIL NAIL FIN AND

ANCHORS SPECIFIED.
FIN MAY BE REMOVED
WHEN REQUIRED BY

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OPENING CONDITIONS

7. CERTIFICATION OF THESE PRODUCT INSTALLATIONS SHALL BE CONSIDERED VOID IF ANY OF THE FOLLOWING APPLY: 1) PRODUCT IS INSTALLED WITHOUT A BUILDING PERMIT FROM THE APPLICABLE LOCAL BUILDING DEPARTMENT. 2) PRODUCT IS INSTALLED BY ANYONE OTHER THAN A LICENSED CONTRACTOR EXPERIENCED WITH INSTALLATIONS OF THIS TYPE OF PRODUCT. 3) IF CHANGES HAVE OCCURRED TO THE PRODUCT'S CERTIFICATION ENTITY'S CERTIFICATE THAT CAUSE THESE INSTALLATIONS TO BE INCORRECT OR INCONSISTENT WITH WHAT HAS BEEN TESTED.

8. THE LEAST DESIGN PRESSURE SPECIFIED EITHER IN THIS DRAWING OR IN THE PRODUCTS CERTIFICATION SHALL CONTROL FOR THE INSTALLED PRODUCT.

9. THESE DRAWINGS CERTIFY THE PRODUCT INSTALLATION ONLY. WATER PROOFING OF THE INSTALLED PRODUCT IS NOT PART OF THIS INSTALLATION CERTIFICATION. THAT RESPONSIBILITY SHALL BE THAT OF THE MANUFACTURER &/OR INSTALLER.

-STRIKE PLATE

ACTIVE

INACTIVE

SIMILAR % OPPOSITE B1

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SEE

"FRAME ANCHOR

FRAME SCREWS OR INSTALLATION CLIPS WHERE SHOWN AT HEAD.

REQUIREMENTS TABLE"
ON THIS SHEET FOR

REQUIREMENTS

NO.

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INSTALLATION EVALUATION IS BASED ON APPLICABLE ANCHOR STANDARDS AND/OR INFORMATION & RESULTS FROM APPLICABLE TEST REPORTS. THE FLORIDA BUILDING CODE VERSION CONSIDERED WITH THE EVALUATION WAS THAT IN FORCE AT THE TIME OF THE EVALUATION. IN THE EVENT OF CODE VERSION CHANGES/UPDATES OR IN THE EVENT THAT NEW OR ADDITIONAL TESTING IS COMPLETED ON THE REFERENCED PRODUCT, PRIOR TO STATING CODE COMPLIANCE WITH THE STATE, THE MANUFACTURER SHALL CONFIRM WITH THE INSTALLATION EVALUATION EMGINEER OF RECORD THAT THE INSTALLATIONS SPECIFIED HERE—IN ARE CURRENT WITH THE THEN CURRENT TESTING, CODE AND APPLICABLE STANDARDS. FOR MAX. FRAME HEIGHT, SEE "ALLOWABLE DESIGN PRESSURE" TABLE ON THIS SHEET

STRIKE). SEE "FRAME

SILL SCREWS WHERE SHOWN.

OF CORNERS & 5" TO 7" O.C. SEE "FRAME ANCHOR REQUIREMENTS TABLE" ON THIS SHEET FOR REQUIREMENTS.

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FASTENER WITHIN 4"
CORNERS & 5" TO

SEE "FRAME

ANCHOR

ANCHOR

STRIKE SCREWS INTO

SUBSTRATE (1 PER

TABLE" ON THIS SHEET FOR SCREW REQUIREMENTS

REQUIREMENTS.

TABLE" ON THIS SHEET FOR REQUIREMENTS

REQUIREMENTS

(4) MIN. 2X_ WOOD FRAME OR BUCK (MIN. GR. 3 & G=0.55) (4) MIN. 2X_ ₹ Z <u>≤</u> MIN. 18 GA. 33 KSI METAL STUD MIN. 1/8" THK 6063-T5 ALUM. C-90 CMU/2500 PSI CONCRETE 18 GA. 33 KSI METAL STUD (MIN. GR. 3 & G=0.55) 2X_ WOOD FRAME OR BUCK (MIN. GR. 3 & G=0.55) 1/8" THK A36 STEEL /8" THK A36 STEEL
" THK 6063-T5 ALUM. OPENING TYPE (SUBSTRATE) INSTALLATION CLIP INSTALLATION FRAME ANCHOR REQUIREMENTS TABLE NO. 8 GR. 5 SELF T NO. 8 GR. 5 SELF T CLIP SCREWS NO. NO. Š. NO. 8 GR. 5 SELF TAP/DRILL SCREW NO. 10 SMS OR WOOD SCREW (1) 1/4" CONCRETE SCREW SCREWS (BENT & 3-PIECE CLIPS) 10 GR. 5 SELF TAP/DRILL SCREW 10 GR. 5 10 GR. 5 SELF TAP/DRILL FRAME/CLIP/NAIL FIN TO OPENING FASTENER TYPE NO. 8 X 1 1/2" SMS NO. 8 X 1 1/2" SELF TAP/DRILL (STRAIGHT CLIPS) SMS SCREW SCREW FULL EMBED FULL FULL MUMUM 3/8" 3/8" FULL 1/4" EDGE DIST. (2) N/A (2) N/A (2) N/A3/4" 3/4" 1/2"

NO. 8 GR. 5 SELF TAP/DRILL SCREW NO. 8 GR. 5 SELF TAP/DRILL SCREW FULL FULL 1/2" DECREASED TO 1/2"
SCREWS ARE ANGLED TO 20 DEGREES AWAY EDGE DISTANCE MAY BE FROM THE EDGE.

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MAX.

2-PANEL

SLIDING DOOR

DOOR

6" MAX.

EXTERIOR ELEVATION;

(NAIL FIN MOUNT CONDITION)

SCALE: 1/2" = 1'-0"

(4) MIN.

2X_ WOOD FRAME OR BUCK (MIN. GR. 3 & G=0.55)

NO.

8 X 1 1/2"

3/8"

1/2"

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1/8" THK 6063-T5 ALUM.

(3)

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WOOD FRAME OR BUCK GR. 3 & G=0.55)

11 GA.

ROOFING

NAIL

1/2"

(4) MIN. 2X_

2X_ WOOD FRAME OR BUCK (MIN. GR. 3 & G=0.55)

MIN. 1/8" THK 6063-T5 ALUM

NO. 8

GR. 5 GR. 5

SELF

TAP/DRILL

SCREW

FULL

S.

SELF TAP/DRILL

SCREW

FIE 3/8"

1/2"

MIN. 18 GA. 33 KSI METAL STUD

MIN. 1/8" THK A36 STEEL

MIN. 1/8" THK 6063-T5 ALUM.

NO. 8 GR. 5 SELF TAP/DRILL SCREW

FULL

1/2"

1 1/4"

FIL

1/2" 7/2"

1/4"

3/4"

(1) 3/16" CONCRETE SCREW

NO. 8 GR. 5 SELF TAP/DRILL SCREW NO. 8 GR. 5 SELF TAP/DRILL SCREW

NO. 8 SMS OR WOOD SCREW

CMU/2500 PSI CONCRETE

THEIR APPLICABLE STANDARD(S) AND ARE FOUND TO BE CAPABLE OF SUPPORTING ALL LOADS IMPOSED ON THEM UNDER THE GUIDELINES OF THIS DOCUMENT. ANY SUBSTRATES OR CONDITIONS OUTSIDE OF WHAT IS SHOWN HERE—IN SHALL BE SUBJECT TO JOB SPECIFIC ENGINEER'S REVIEW & CERTIFICATION. ANCHOR/SUBSTRATE EVALUATION NOTE: ALL ANCHORS IN THEIR SPECIFIED SUBSTRATES

WHEN NECESSARY, INSTALLATION METHODS MAY WHEN NECESSARY, INSTALLATION METHODS MAY BE MIXED WITH ANY ONE WINDOW SUCH THAT INDIVIDUAL SIDES OF THE WINDOW MAY USE ONE OR THE OTHER ANCHOR METHOD (EXAMPLE: LEFT SIDE MAY USE FRAME SCREWS METHOD WHILE OTHER SIDES USE FIN)

(1) CONCRETE SCREWS SHALL BE ELCO ULTRACONS (C.S.), ELCO CRETE-FLEX (S.S.), ITW RAMSET/RED HEAD TAPCONS (C.S. OR S.S.) OR HILTI KWIK-CON II (C.S OR S.S.).


(2) STANDARD BENT CLIP INSTALLATION SCREWS SHALL BE POSITIONED WITHIN 1/4" OF THE BUCK/SUBSTRATE EDGE AND, IF INTO WOOD, ANGLED 20 TO 30 DEGREES INTO THE BUCK.

(3) WHEN SCREWS ARE USED WITH THE NAIL FIN, THEY MUST BE A WAFFLE HEAD SCREW OR HAAD.

DEPTH REQUIRED TO MEET 1/2" (2X4).

ANCHOR EDGE DISTANCE

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CERTIFICATION

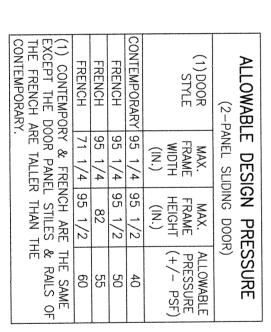WARREN W. P.E.

SCHAEFER, P.E. NO. 44135

SHEET

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유물은 ID/OR INSTALLATION
IEY BE USED FOR
ANY PRODUCT NO
ATED ON THESE DE Y MAY NOT BE USED FOR THE ASSEMBLY LATION OF ANY OTHER PRODUCT NOR MAY FOR RATIONAL AND/OR LOCAL APPROVAL CT NOT PRODUCED BY THE MANUFACTURER SE DRAWINGS.

CHECKED BY: W.W.S.

PL01: 1=24 REVISION DESCRIPTION BY DATE 10/27/09 W.R.M ALTERNATE ANCHOR CONDITIONS 07/05/11 W.R.M. 03/18/13 UPDATE PER NEW TESTING 03/23/16 W.W.S D1 UPDATE PER NEW TESTING ADDED NEW CLIP INSTALL OPTION W.W.S. 06/19/2


LIFESTYLE WITH HGP SERIES FRENCH & CONTEMPORARY NON-IMPACT SLIDING DOOR CONSULTANTS W. W. SCHAEFER ENGINEERING & CONSULTING, P.A.


PELLA CORPORATION 102 MAIN STREET PELLA, IA 50219


DRAWING TITLE

641-621-1000


25601 AYSEN DRIVE PUNTA GORDA, FL 33983 PHONE: 561-744-3424

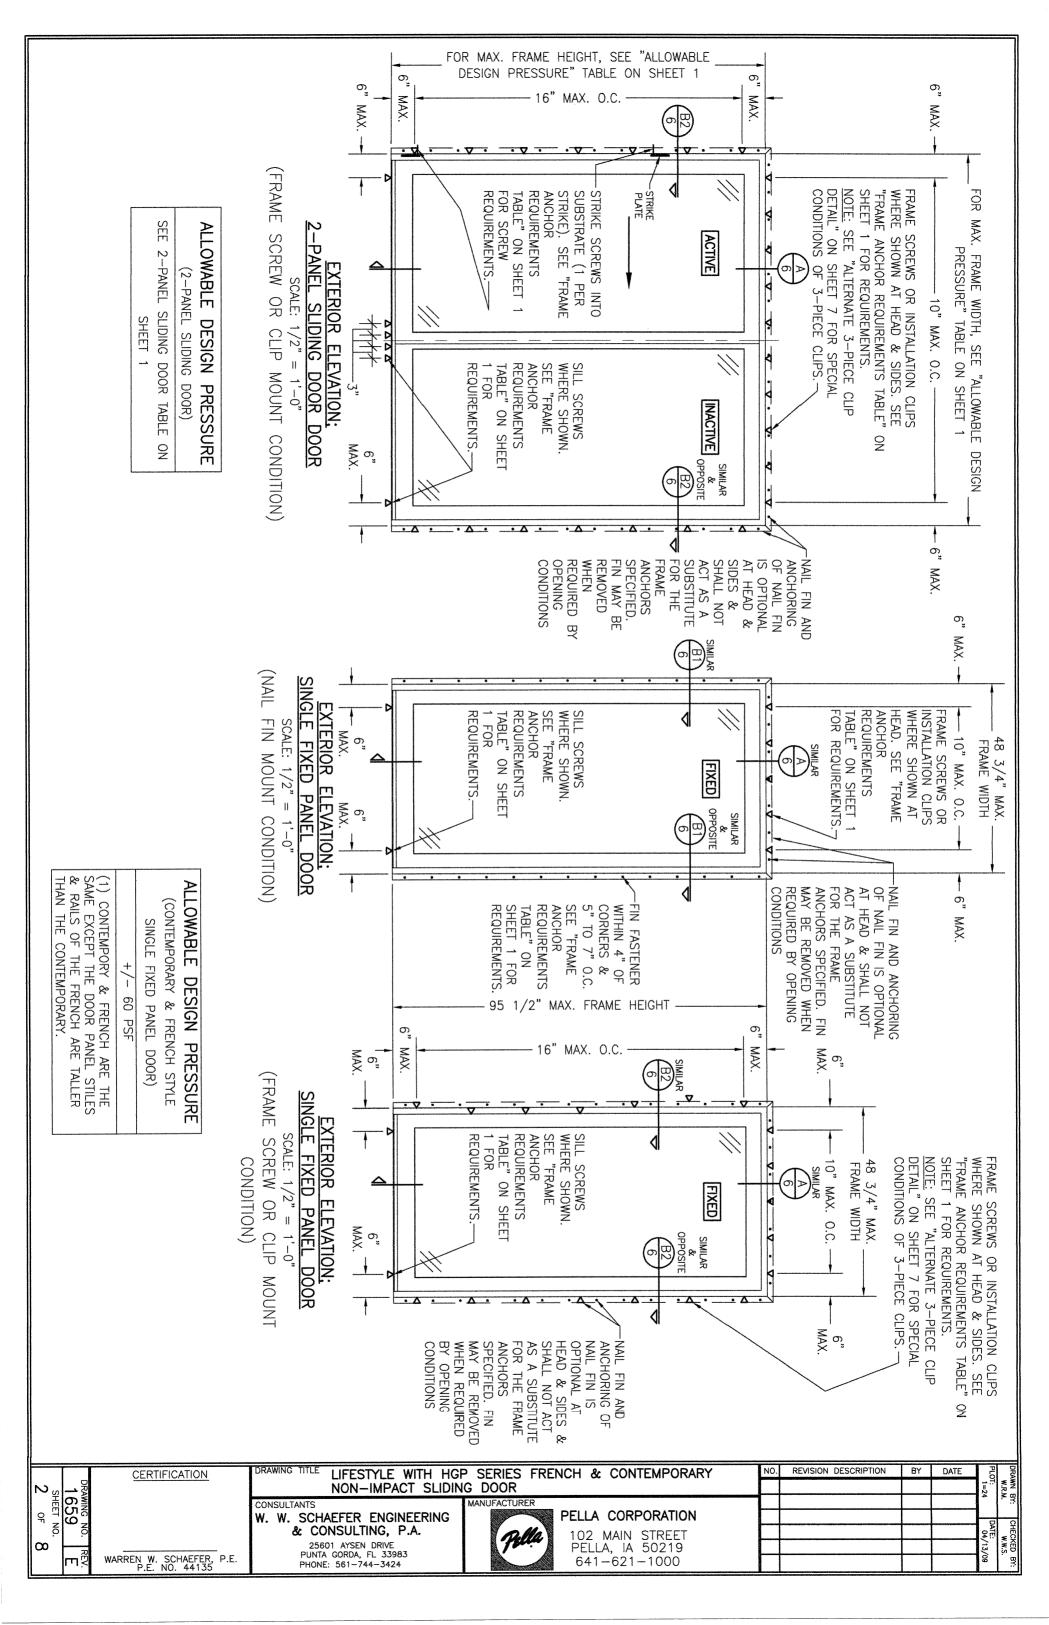

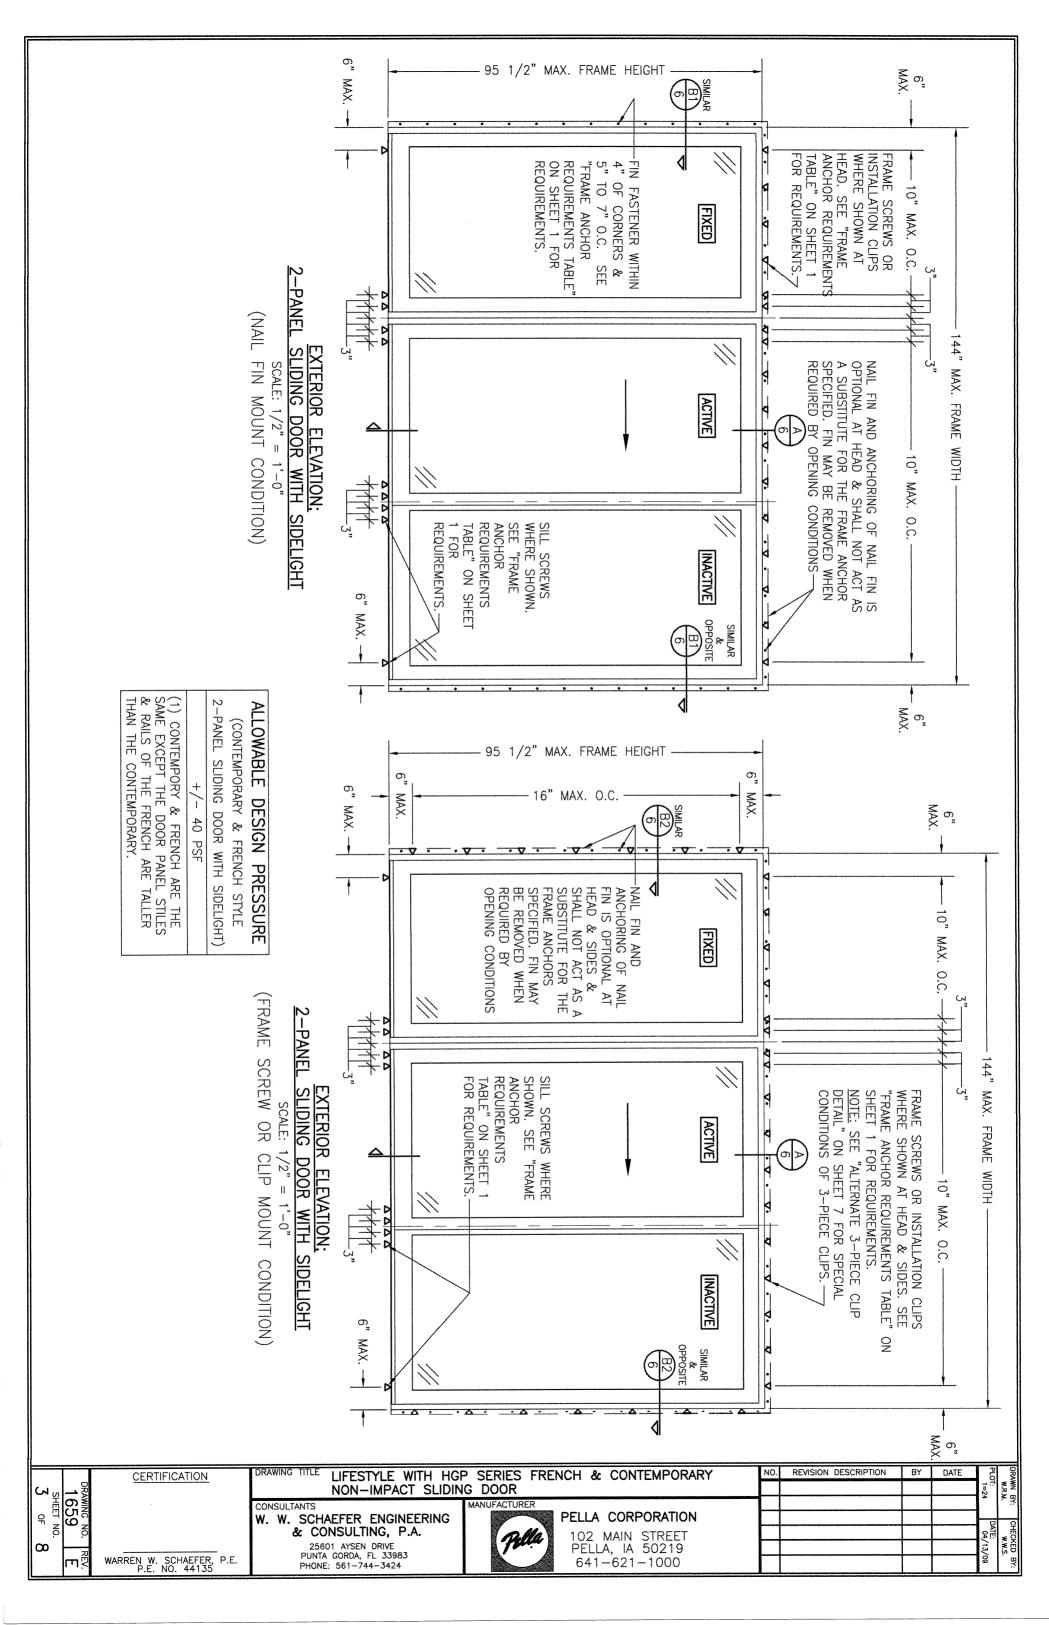

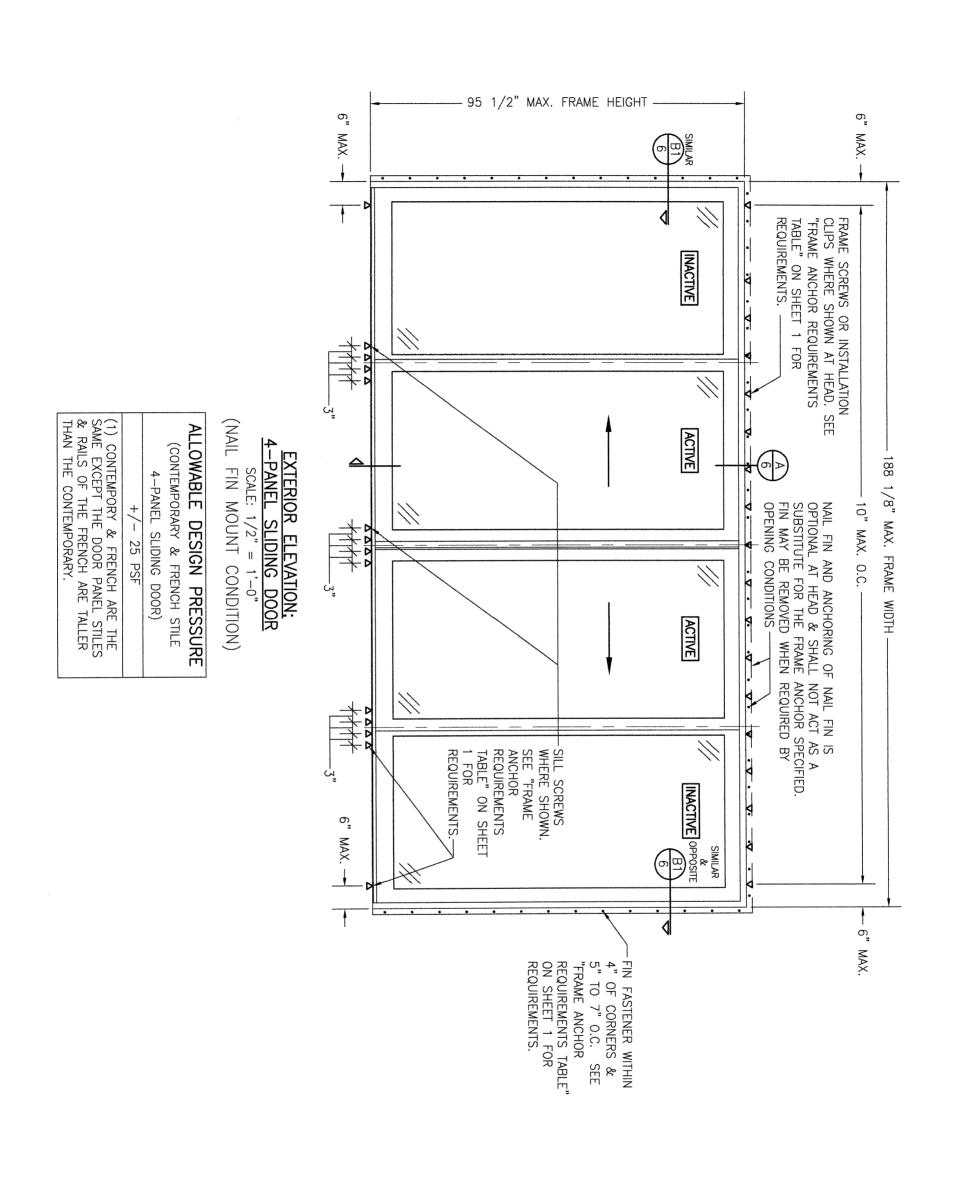

LIFESTYLE WITH HGP SERIES FRENCH & CONTEMPORARY NON-IMPACT SLIDING DOOR DRAWING TITLE REVISION DESCRIPTION BY NO. DATE **CERTIFICATION** 1=24 1659 SHEET N CONSULTANTS W. W. SCHAEFER ENGINEERING & CONSULTING, P.A. PELLA CORPORATION 유 NO. 102 MAIN STREET PELLA, IA 50219 25601 AYSEN DRIVE PUNTA GORDA, FL 33983 PHONE: 561-744-3424 ∞ WARREN W. SCHAEFER, P.E. P.E. NO. 44135 641-621-1000

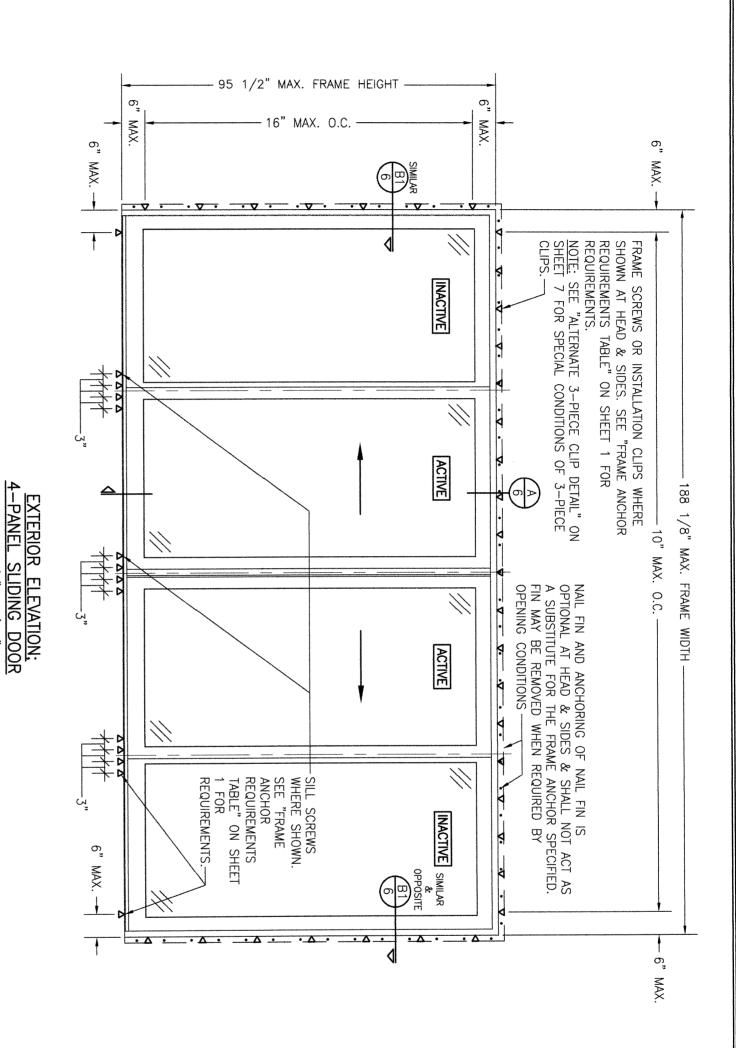

ALLOWABLE DESIGN PRESSURE (CONTEMPORARY & FRENCH STILE

4-PANEL SLIDING DOOR)


+/- 25 PSF


(FRAME SCREW OR CLIP MOUNT CONDITION)


SCALE: 1/2" = 1'-0"

(1) CONTEMPORY & FRENCH ARE THE SAME EXCEPT THE DOOR PANEL STILES & RAILS OF THE FRENCH ARE TALLER THAN THE CONTEMPORARY.

CERTIFICATION O ω → S	DRAWING TITLE LIFESTYLE WITH HGP SERIES FRENCH & CONTEMPORARY NON-IMPACT SLIDING DOOR		NO.	REVISION DESCRIPTION	BY	DATE	PLOT: 1=24	DRAWN BY: W.R.M.
間の	CONSULTANTS W. W. SCHAEFER ENGINEERING & CONSULTING, P.A. 25601 AYSEN DRIVE PUNTA GORDA, FL 33983 PHONE: 561-744-3424	PELLA CORPORATION 102 MAIN STREET PELLA, IA 50219 641-621-1000					DATE	Y: CHECKED BY: W.W.S.

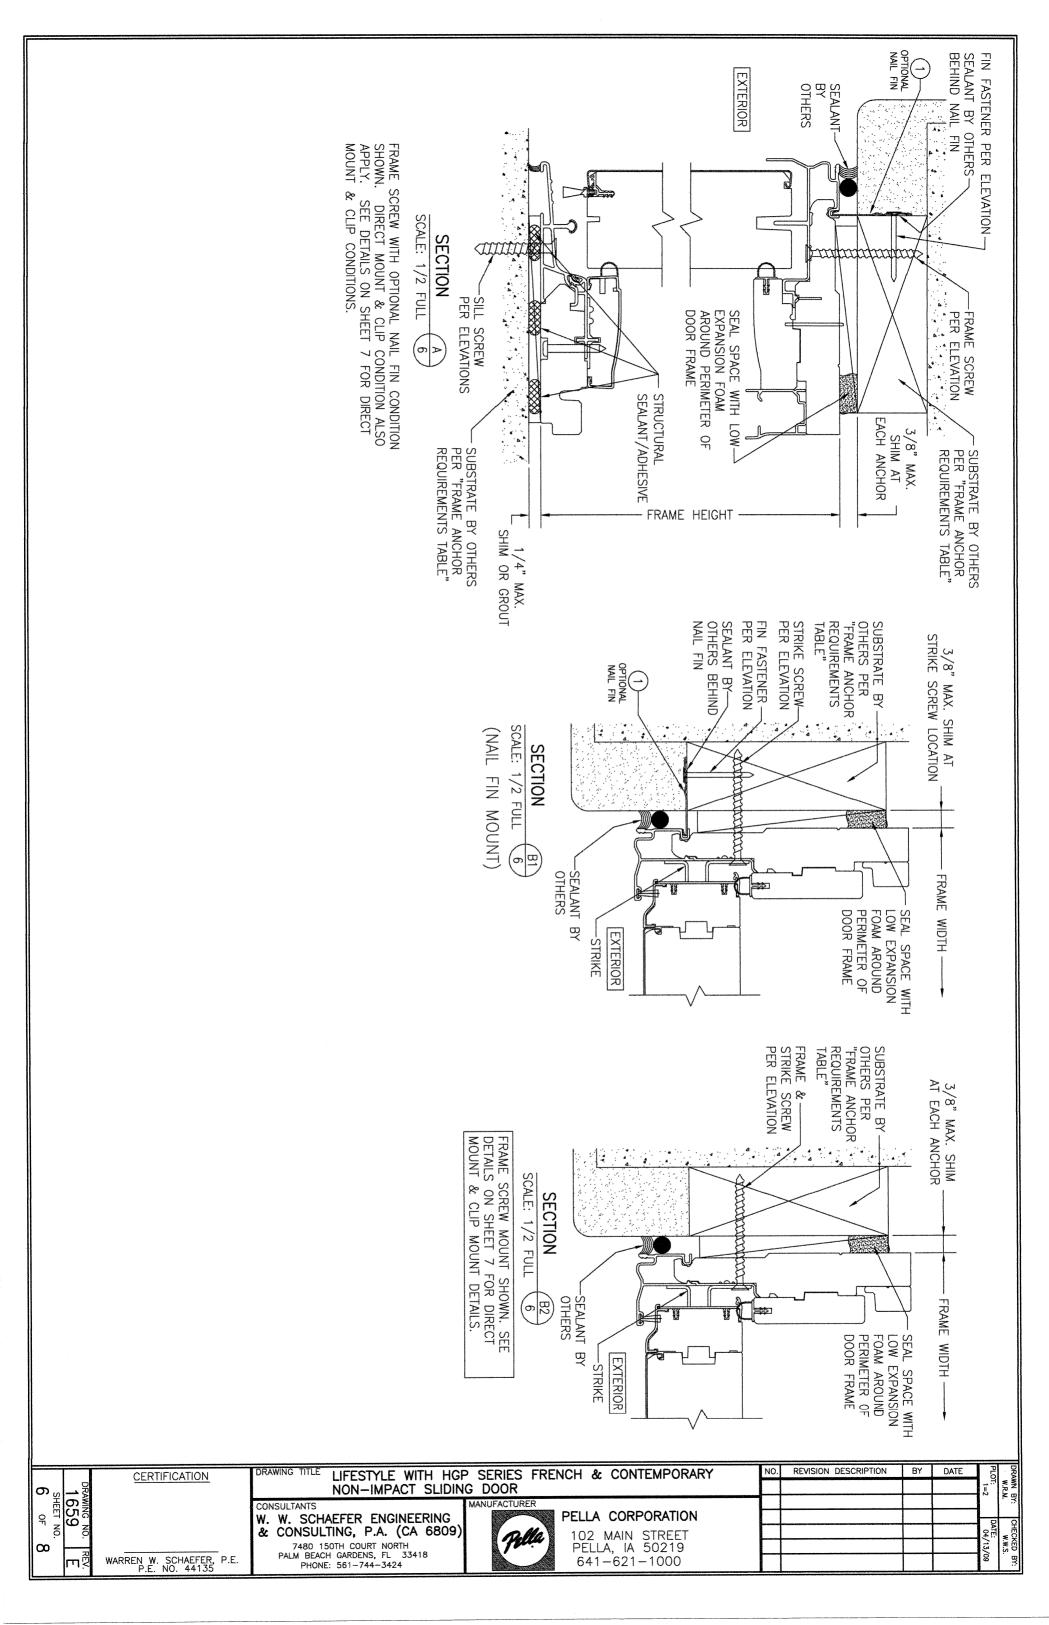


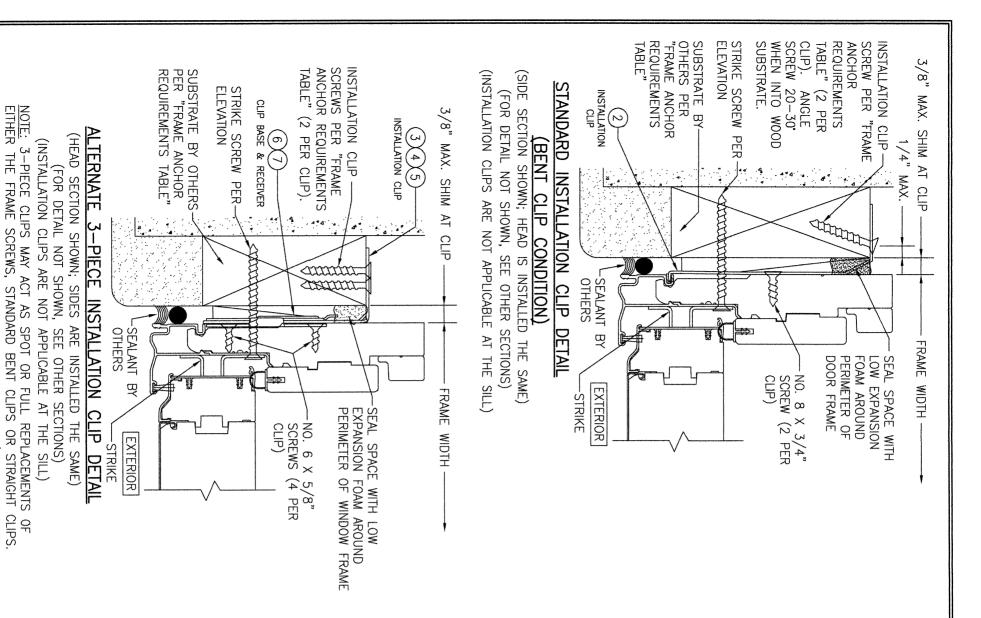

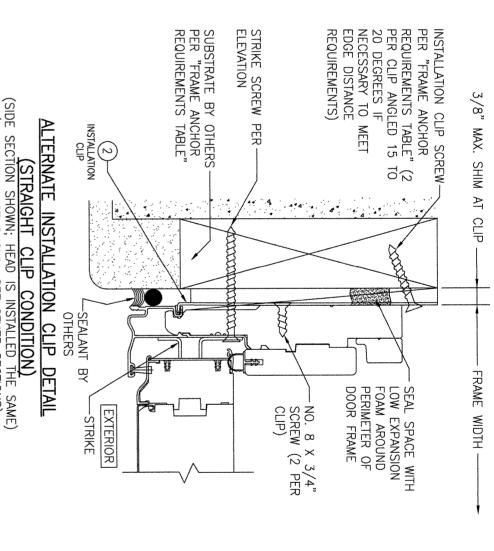

BY

DATE

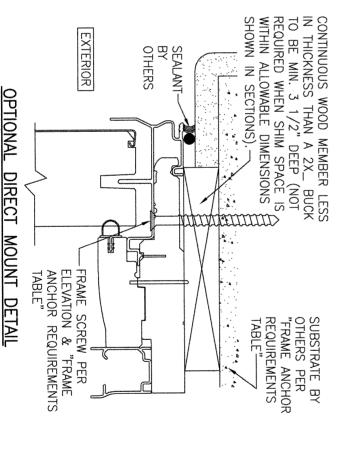

THEREFORE, ANY ONE OR ALL OF THE FRAME SCREWS/CLIPS SPECIFIED IN

(HEAD SECTION SHOWN; SILL & SIDES ARE INSTALLED THE SAME)

TO SUBSTRATE WITH SPACER

(FOR DETAIL NOT SHOWN, SEE OTHER SECTIONS)

LIFESTYLE WITH HGP SERIES FRENCH & CONTEMPORARY REVISION DESCRIPTION DRAWING TITLE CERTIFICATION NON-IMPACT SLIDING DOOR 659 CONSULTANTS PELLA CORPORATION W. W. SCHAEFER ENGINEERING 유 N O & CONSULTING, P.A. (CA 6809) 102 MAIN STREET PELLA, IA 50219 7480 150TH COURT NORTH ∞ PALM BEACH GARDENS, FL PHONE: 561-744-3424 WARREN W. SCHAEFER, P.E. P.E. NO. 44135 641-621-1000

(INSTALLATION CLIPS ARE NOT APPLICABLE AT THE SILL)

(FOR DETAIL NOT SHOWN, SEE OTHER SECTIONS)

